




FOUL WATER SEWER FROM MANHOLE FFW-27 TO FFW-50
 HORIZONTAL SCALE 1:500
 VERTICAL SCALE 1:100

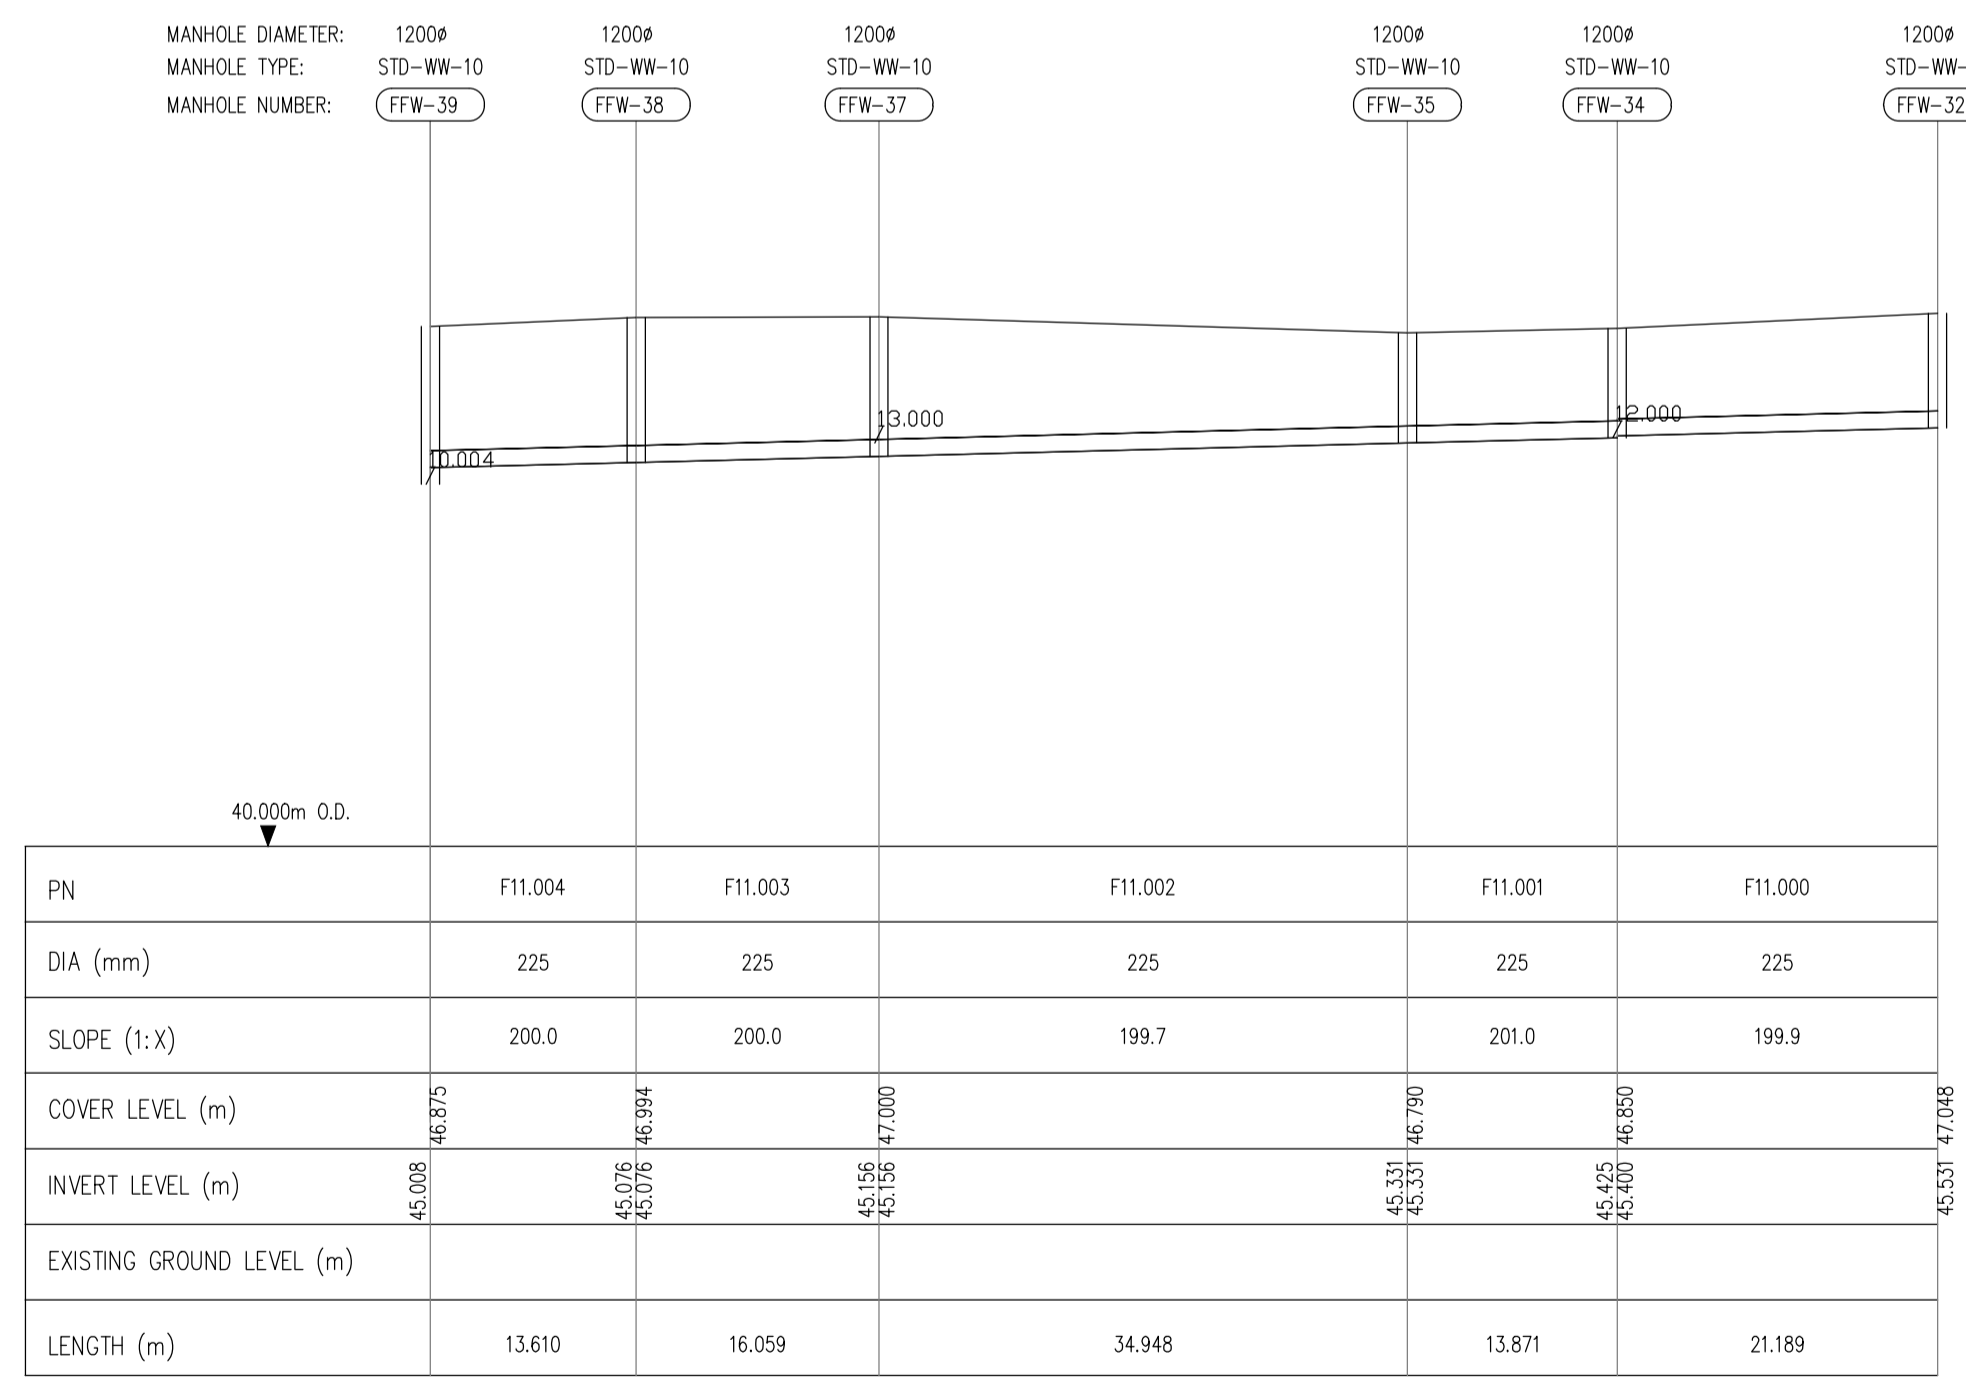


FOUL WATER SEWER FROM MANHOLE FFW-32 TO FFW-39
 HORIZONTAL SCALE 1:500
 VERTICAL SCALE 1:100

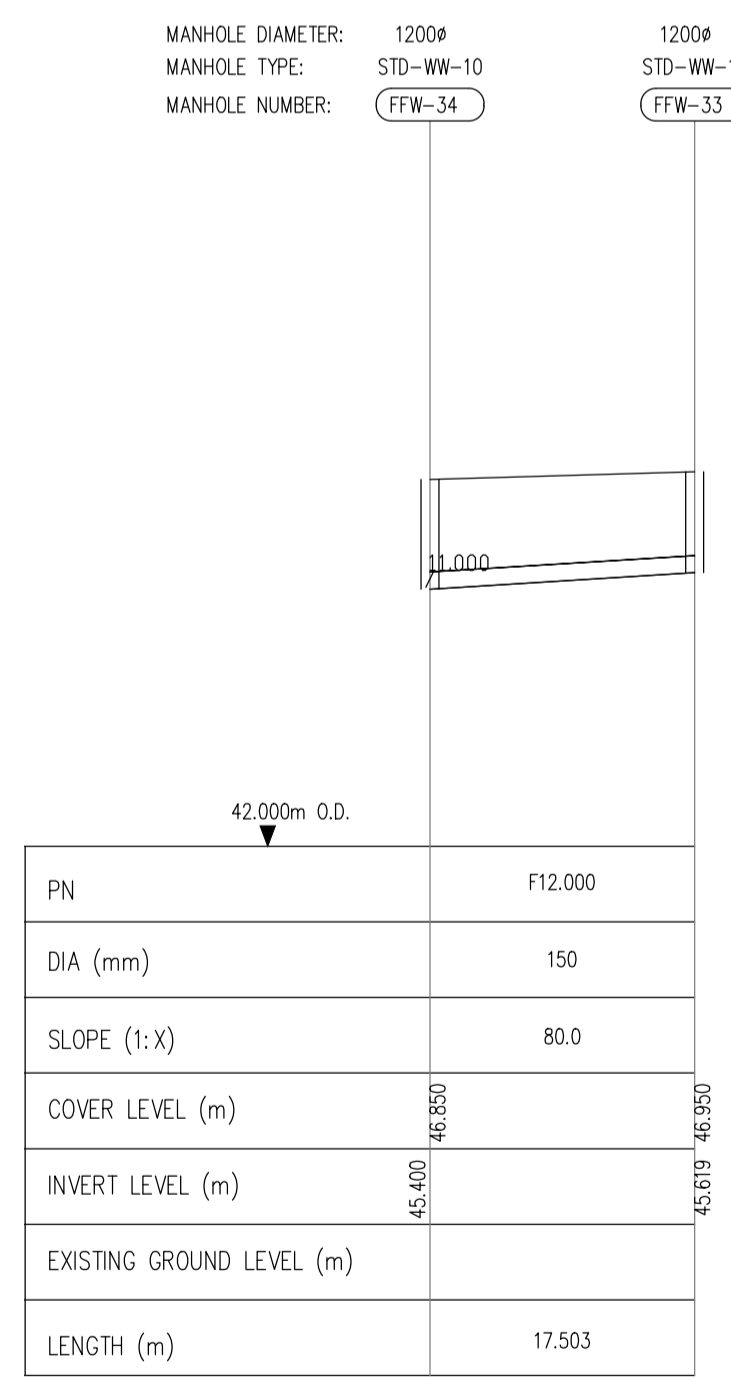

FOUL WATER SEWER FROM MANHOLE FFW-33 TO FFW-34
 HORIZONTAL SCALE 1:500
 VERTICAL SCALE 1:100

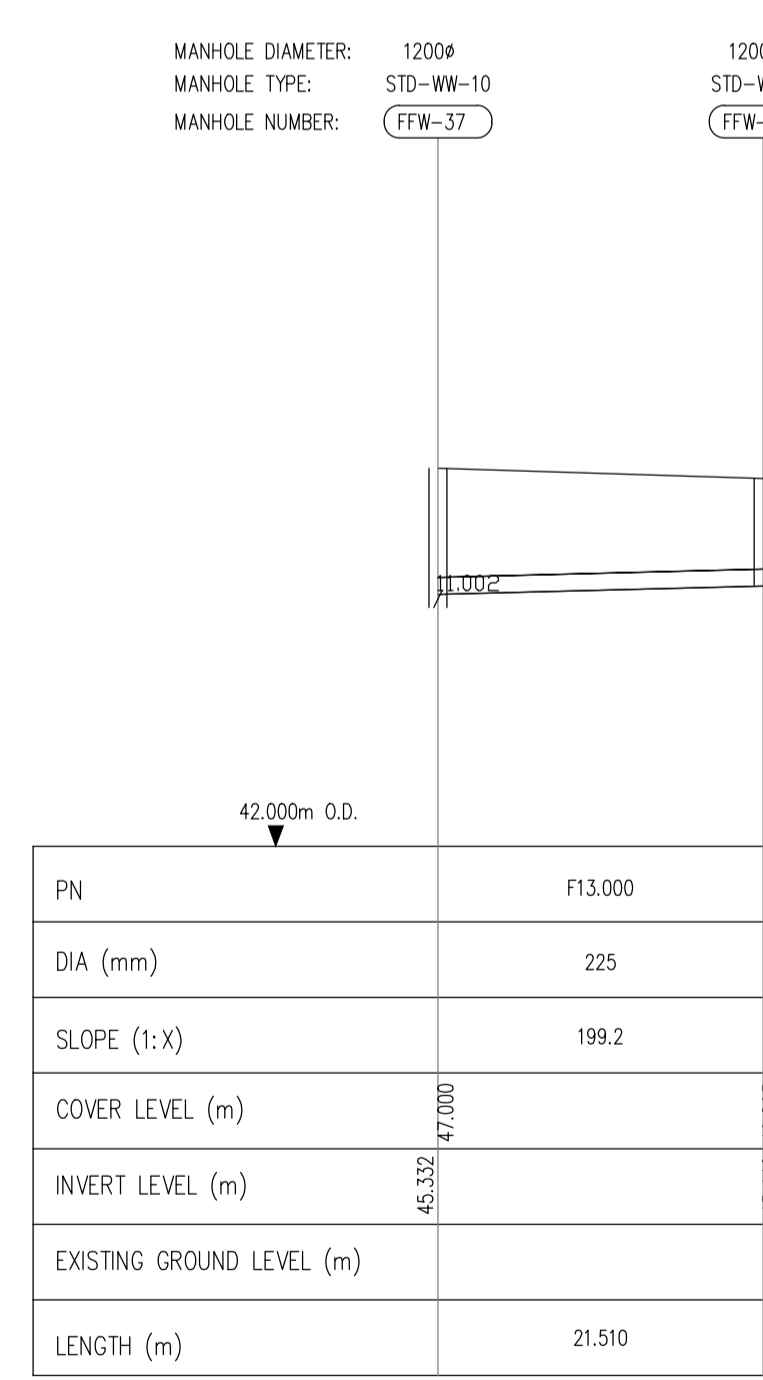

FOUL WATER SEWER FROM MANHOLE FFW-36 TO FFW-37
 HORIZONTAL SCALE 1:500
 VERTICAL SCALE 1:100

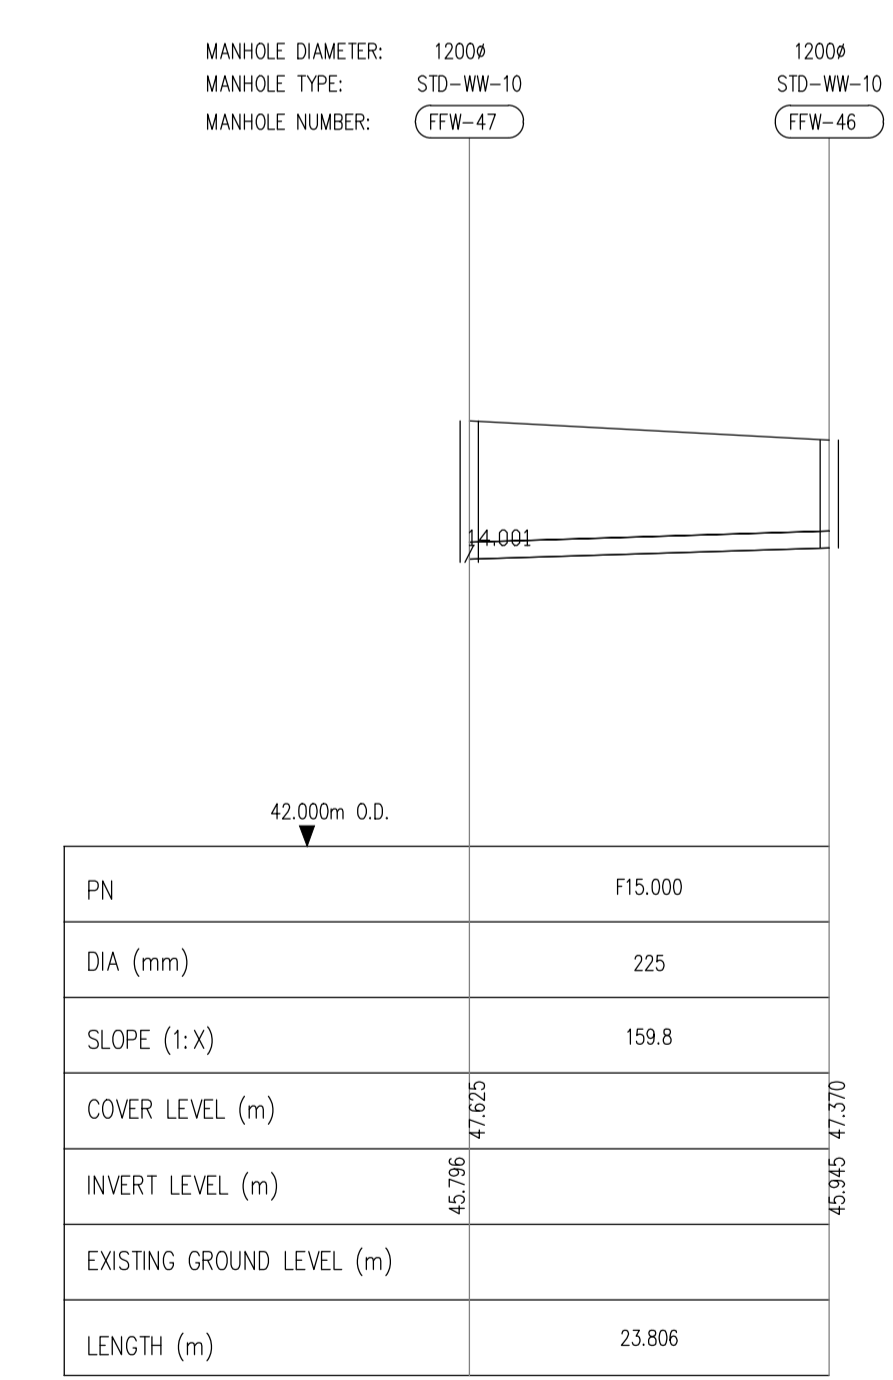

FOUL WATER SEWER FROM MANHOLE FFW-46 TO FFW-47
 HORIZONTAL SCALE 1:500
 VERTICAL SCALE 1:100

- NOTES:
- REFER TO DRG. No. D061-012 TO D061-015 FOR DRAINAGE LAYOUT
 - REFER TO DRG. No. D061-016 FOR MANHOLE DETAILS
 - REFER TO DRG. No. D061-017 FOR PIPE BEDDING DETAILS
 - REFER TO DRG. No. D061-068 FOR BACKDROP MANHOLE DETAILS

PLANNING DRAWING
 NOT FOR CONSTRUCTION THIS
 DRAWING HAS BEEN ISSUED FOR
 INFORMATION PURPOSES ONLY
 AND MUST NOT BE USED FOR
 CONSTRUCTION UNDER ANY
 CIRCUMSTANCES

- NOTES
- For setting out refer to Architect's drawings.
 - This drawing to be read in conjunction with all other Architectural and Engineering drawings and all other relevant drawings and Specifications.
 - DO NOT SCALE THIS DRAWING. Use figured dimensions only.
 - No part of this document may be reproduced or transmitted in any form or stored in any retrieval system of any nature without the written permission as copyright holder except as agreed for use on the project for which the document was originally issued.
 - Ordnance Survey Ireland Licence Number EN 0074019

Rev. No.	Date	REVISION NOTE
A	01.11.2019	ISSUED TO IRISH WATER
B	15.11.2019	ISSUED FOR PLANNING

Dim. By	Chkd. By	Architect	Project	Title	Rev. No.	Revised
DD	RFM	Conroy Crowe Kelly	Belmont	Proposed Foul Longitudinal Sections Sheet 3 Of 5	D061/059	B
Date	Scale	As Shown				
Oct 2019	@A1					

CS Consulting Group
 DUBLIN | LONDON | LIMERICK

Head Office
 19-22 Dame Street, Dublin 2.
 T: +353 (0)1 5480863 F: +353 (0)1 9011355
 e: info@csconsulting.ie
 w: www.csconsulting.ie

Quality Environment
 Health & Safety

NSAI Certified

ISO 9001:2008
 ISO 14001:2004
 ISO 50001:2011
 OHSAS 18001:2007

